


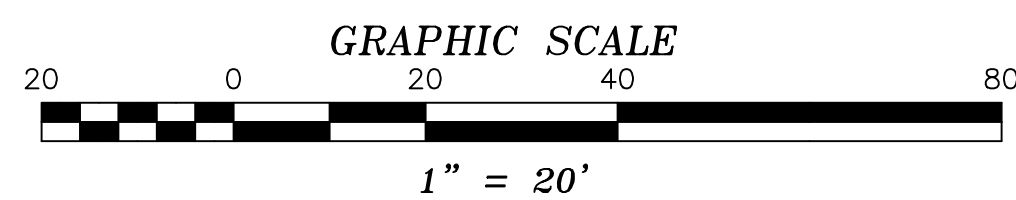


SITE PLAN
SCALE: 1" = 20'




MATERIALS

- (A) CLEAN CRUSHED ANGULAR STONE, 3/4" - 2" NOMINAL
- (B) CLEAN CRUSHED ANGULAR STONE, 3/4" - 2" NOMINAL
- (C) 3" MINUS BANK RUN GRAVEL
- (D) FINE GRADED CRUSHED GRAVEL; TOPSOIL (SEE FINAL DESIGN)

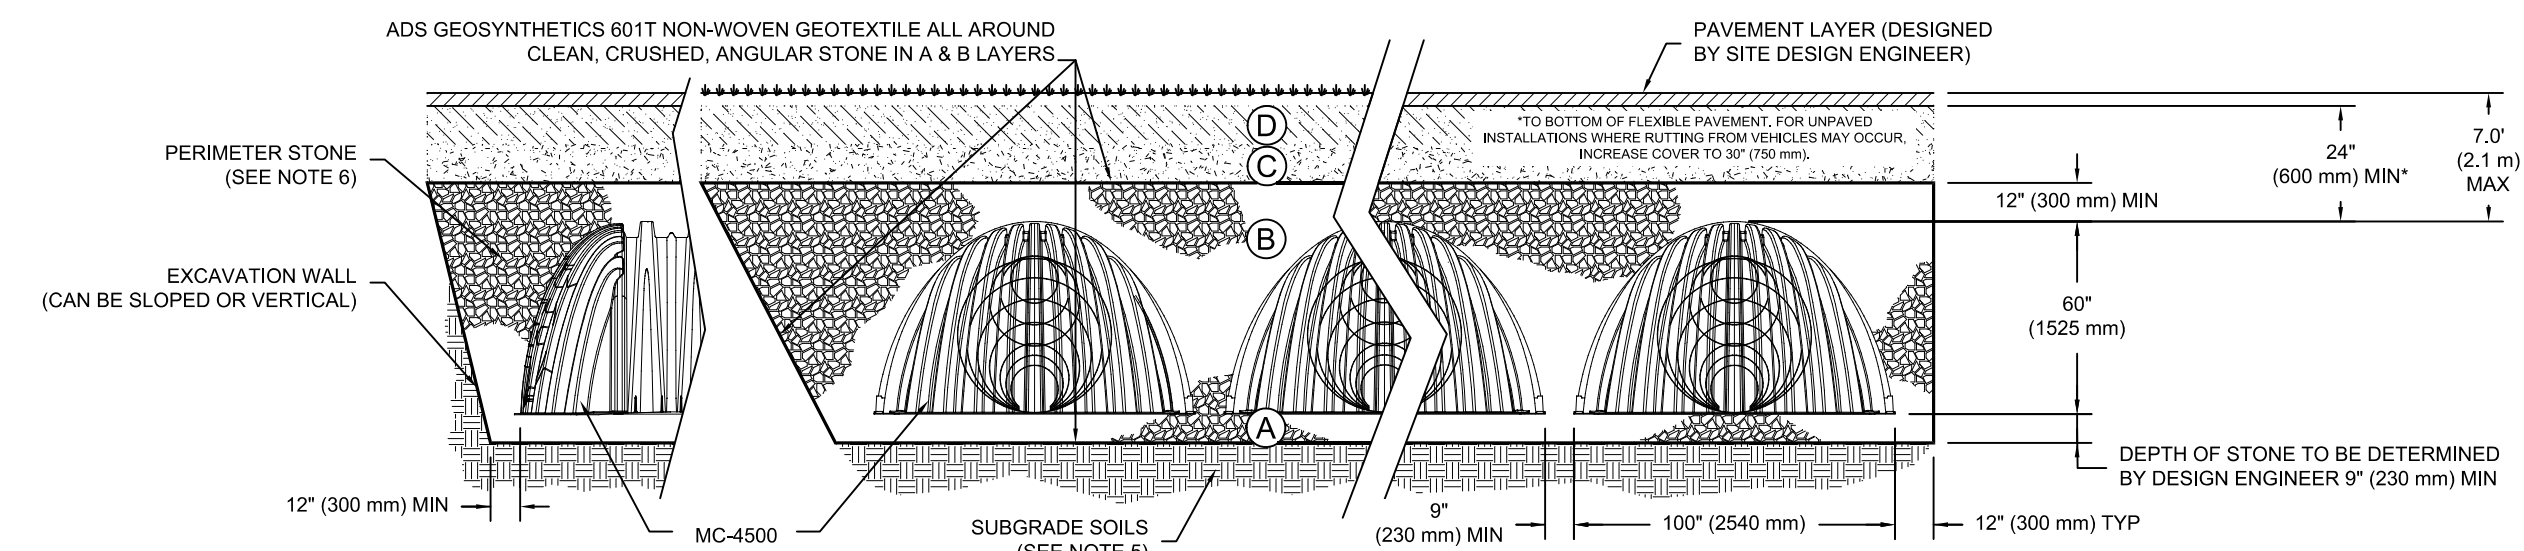

TYPICAL CROSS-SECTION
NOT TO SCALE

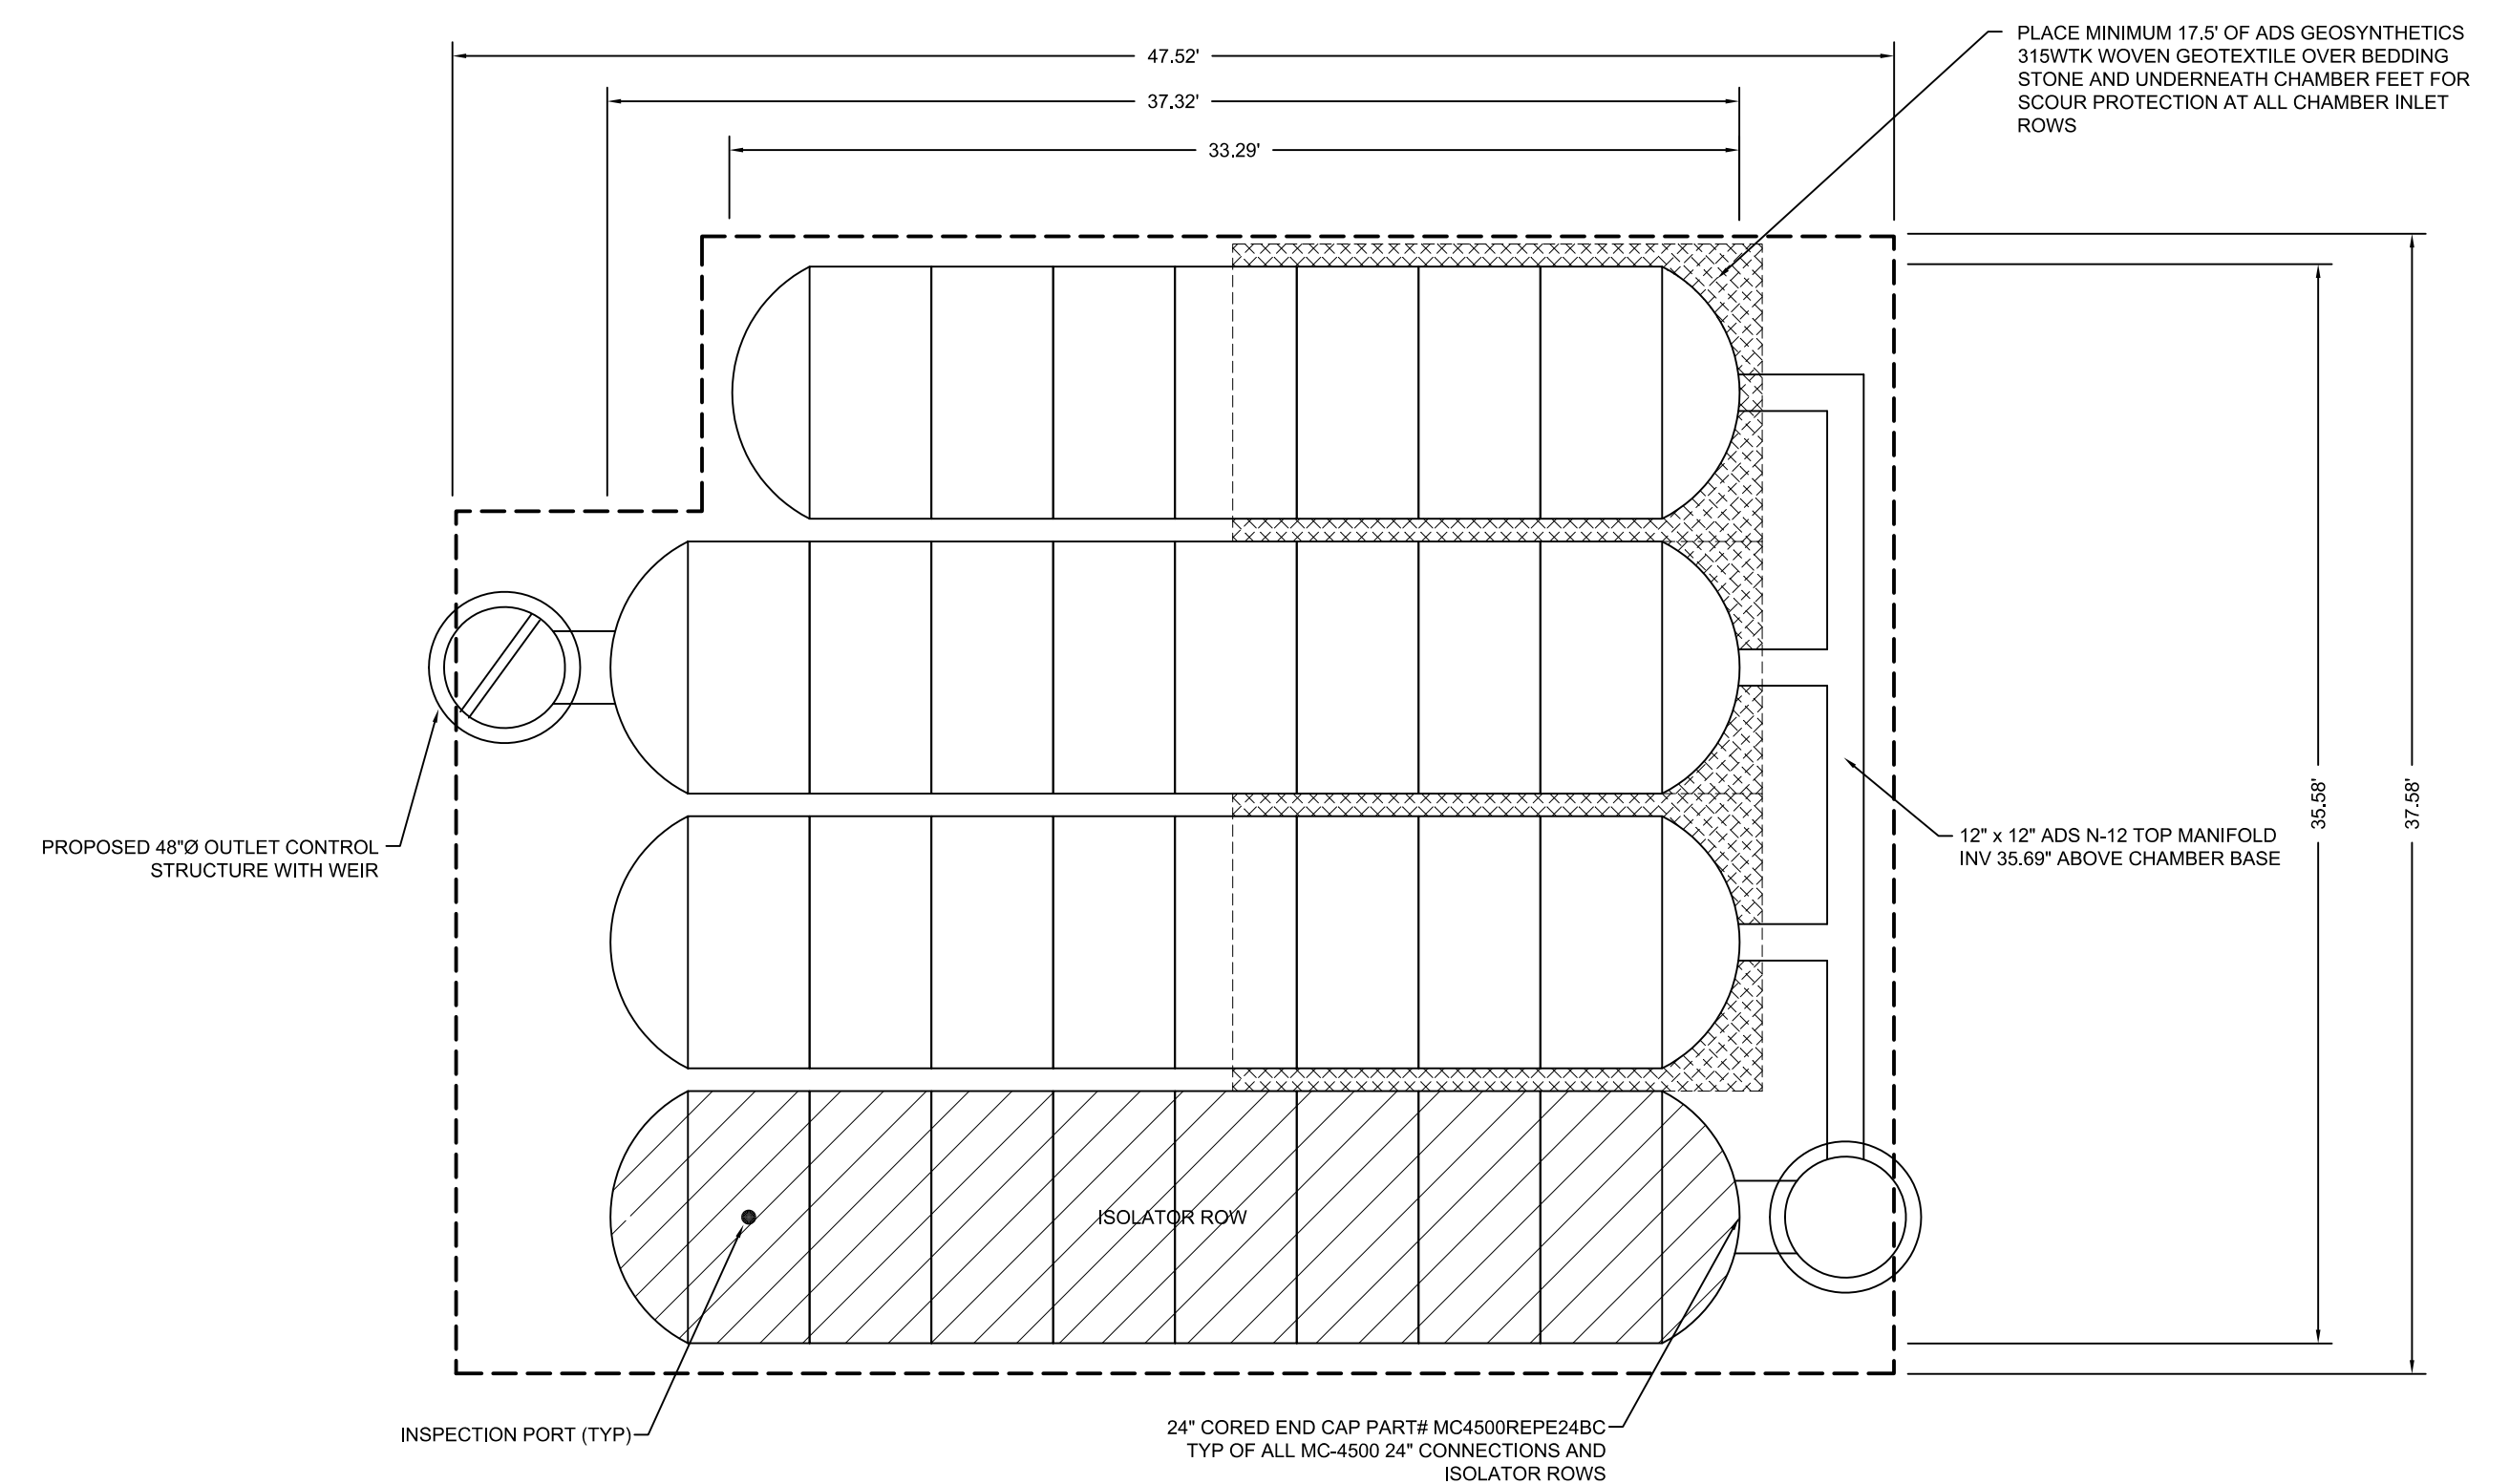

CHAMBER SYSTEM LAYOUT
NOT TO SCALE

NOTES:

1. SITE TOPOGRAPHY BASED ON A FIELD SURVEY BY CHASE & CHASE SURVEYORS, OCTOBER 2018. THE VERTICAL DATUM IS APPROXIMATE NAVD 1988.
2. ADDITIONAL PIPE INVERT INFORMATION WILL BE REQUIRED PRIOR TO PREPARATION OF FINAL DESIGN.
3. AN ANALYSIS OF THE HYDRAULIC CAPACITY OF THE EXISTING DOWNSTREAM STORMWATER COLLECTION AND TREATMENT SYSTEM WILL BE REQUIRED FOR FINAL DESIGN. ADDITIONAL PERMITTING OF THOSE SYSTEMS WILL BE REQUIRED.

CONCEPTUAL PLAN NOT FOR CONSTRUCTION

PROPOSED STORMWATER IMPROVEMENTS
LAMOILLE VALLEY UNION
HIGH SCHOOL
ROUTE 100 MORRISVILLE, VERMONT

SCALE: 1" = 20'	DATE: 10/12/18	PROJ. #2018-120B	DWG. # 120B1
DRAWN BY: KKA	CHECKED BY: AT	FB/PG. EFB	SHEET C1

WATERSHED
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